New Dwelling

Architectural Drawing Index

Architectural Drawing Index

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Client:

Address:

Date Started: 23-08-2020

Drawing No: 620-7160

Sheet: Ar01

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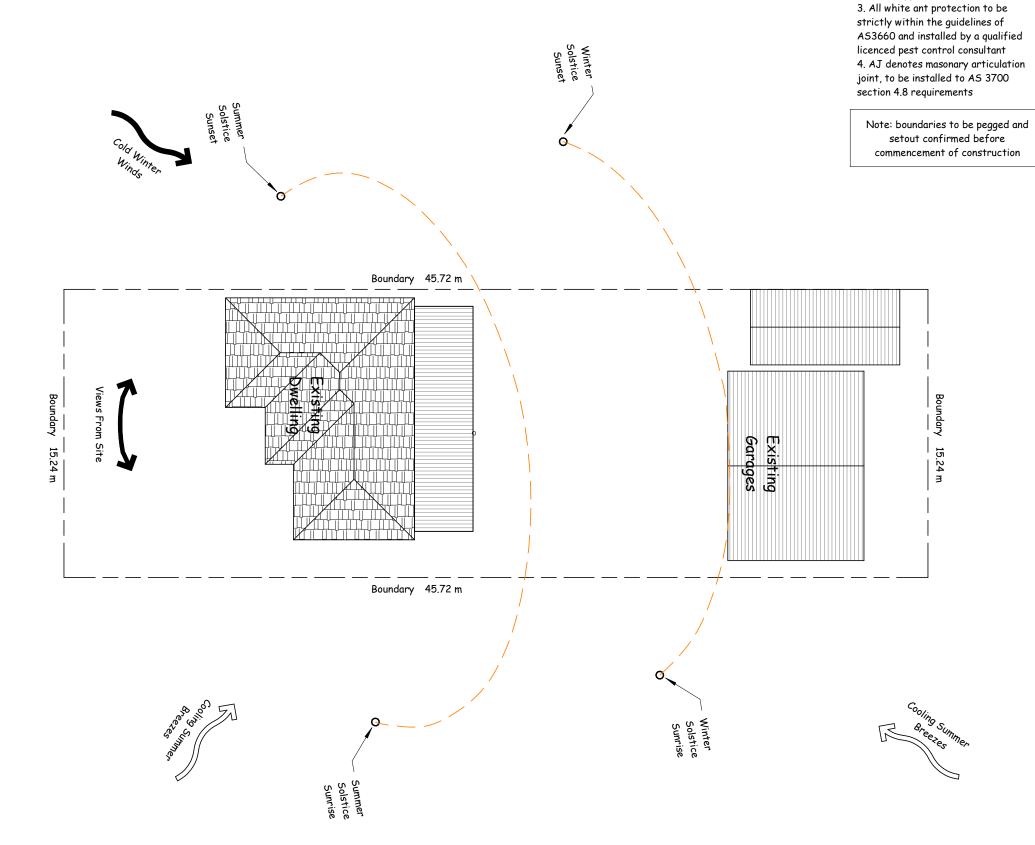
Locality Plan

<u>Area Plan</u>



Noise Source

Cold Winter Winds





PLAN VISION

27 Eighth Street, Adamstown
W/ (02) 40231266 M/ 0414 011 483

Use Dimensions in preference to scale. Site

BUILDERS NOTE:

General Notes

exterior applications

Bracing and tie-down details to the engineers details and AS1684.2
 All timber and steel to be installed and treated to the manufacturers specifications, expecially for any

verify all dimensions before ordering Materials. Footings information shown on these plans may have to be changed if Builders site excavations reveal non-virgin ground. Consultation of Plan Vision Australia Pty Ltd would then be necessary to determine the required changes. Materials are under no circumstances to be ordered direct off plans. Materials to be ordered are only to be ordered from a Builders or applicable product manufacturers seperate site confirmed Materials list. Plans are not intended to be the absolute medium for construction information

Wind Class: N2 (W33N) (Assumed)

accuracy due to site discrepencies. See schedule of specifications for further

Site Class: 'M' Soil Class: 'M' Site / Soil Class Assumed

SURVEY NOTE:

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Full project specific detailed survey plans have not been supplied to Plan Vision for

planning purposes.
See schedule of specifications for details.

| Revision Schedule | |
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| | Description |
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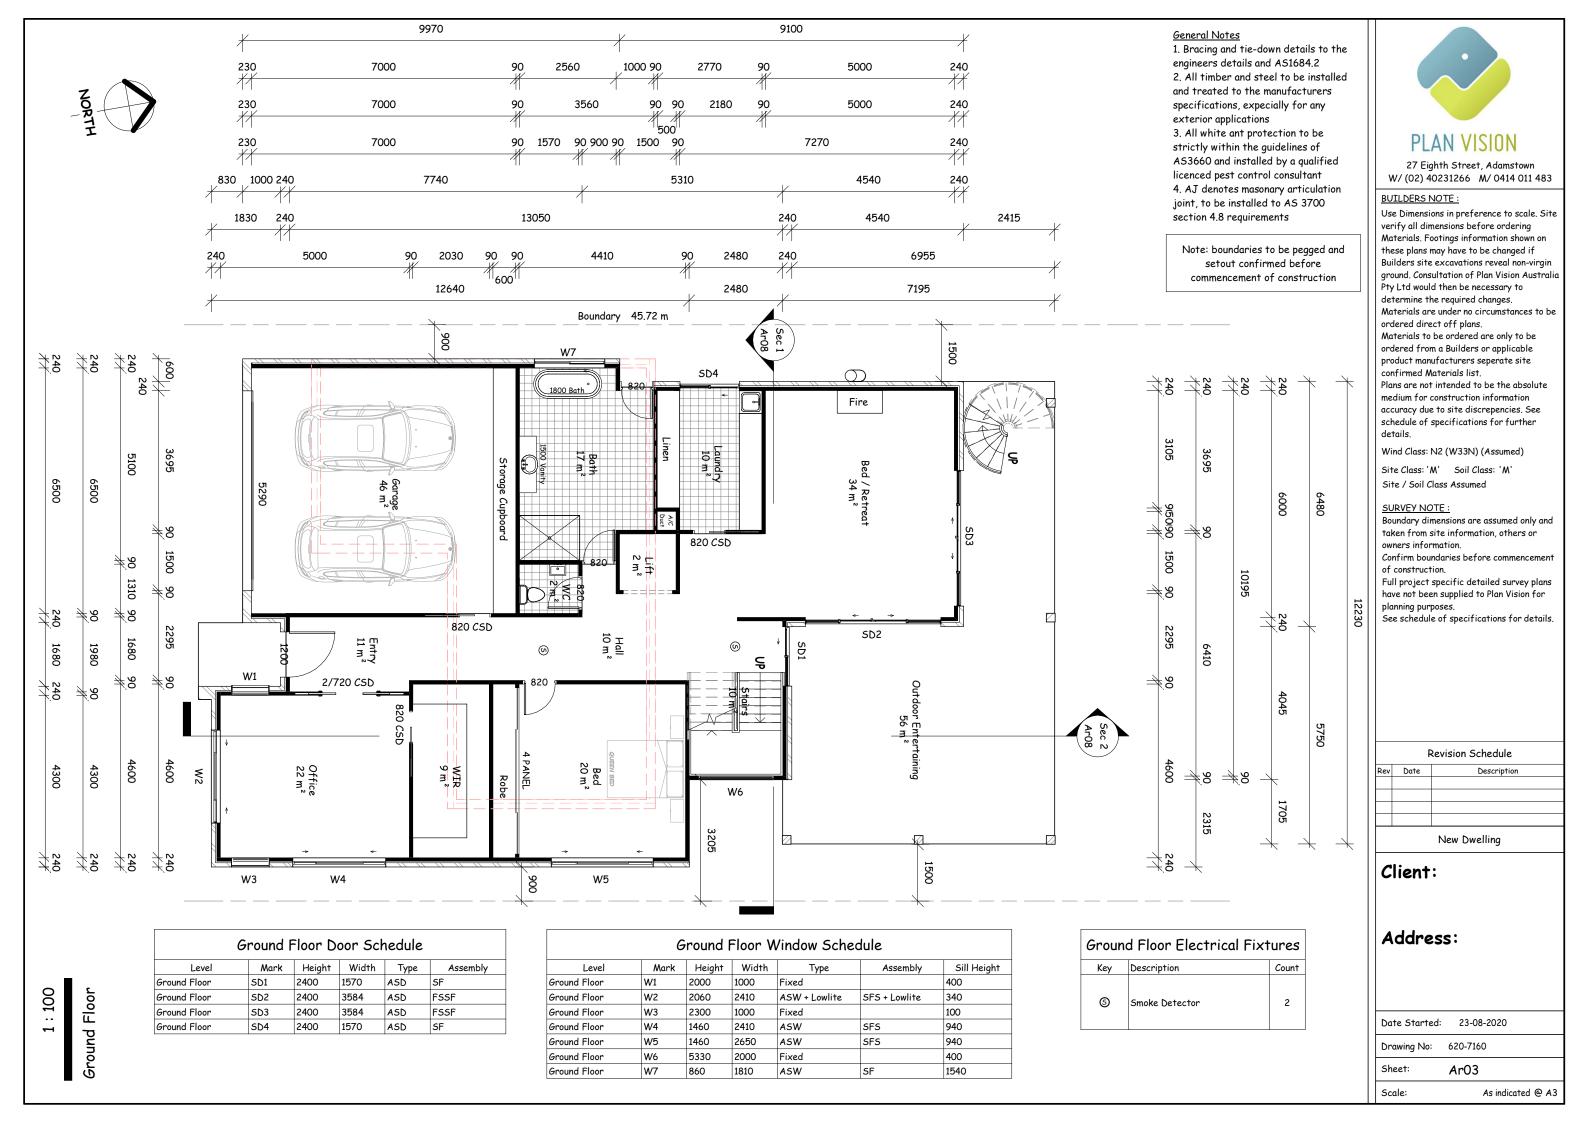
New Dwelling


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Address:

| Date Started: | 23-08-20 |)20 |
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| Drawing No: | 620-7160 | |
| Sheet: | Ar02 | |
| Scale: | | 1:200 @ A3 |

Site Analysis Plan





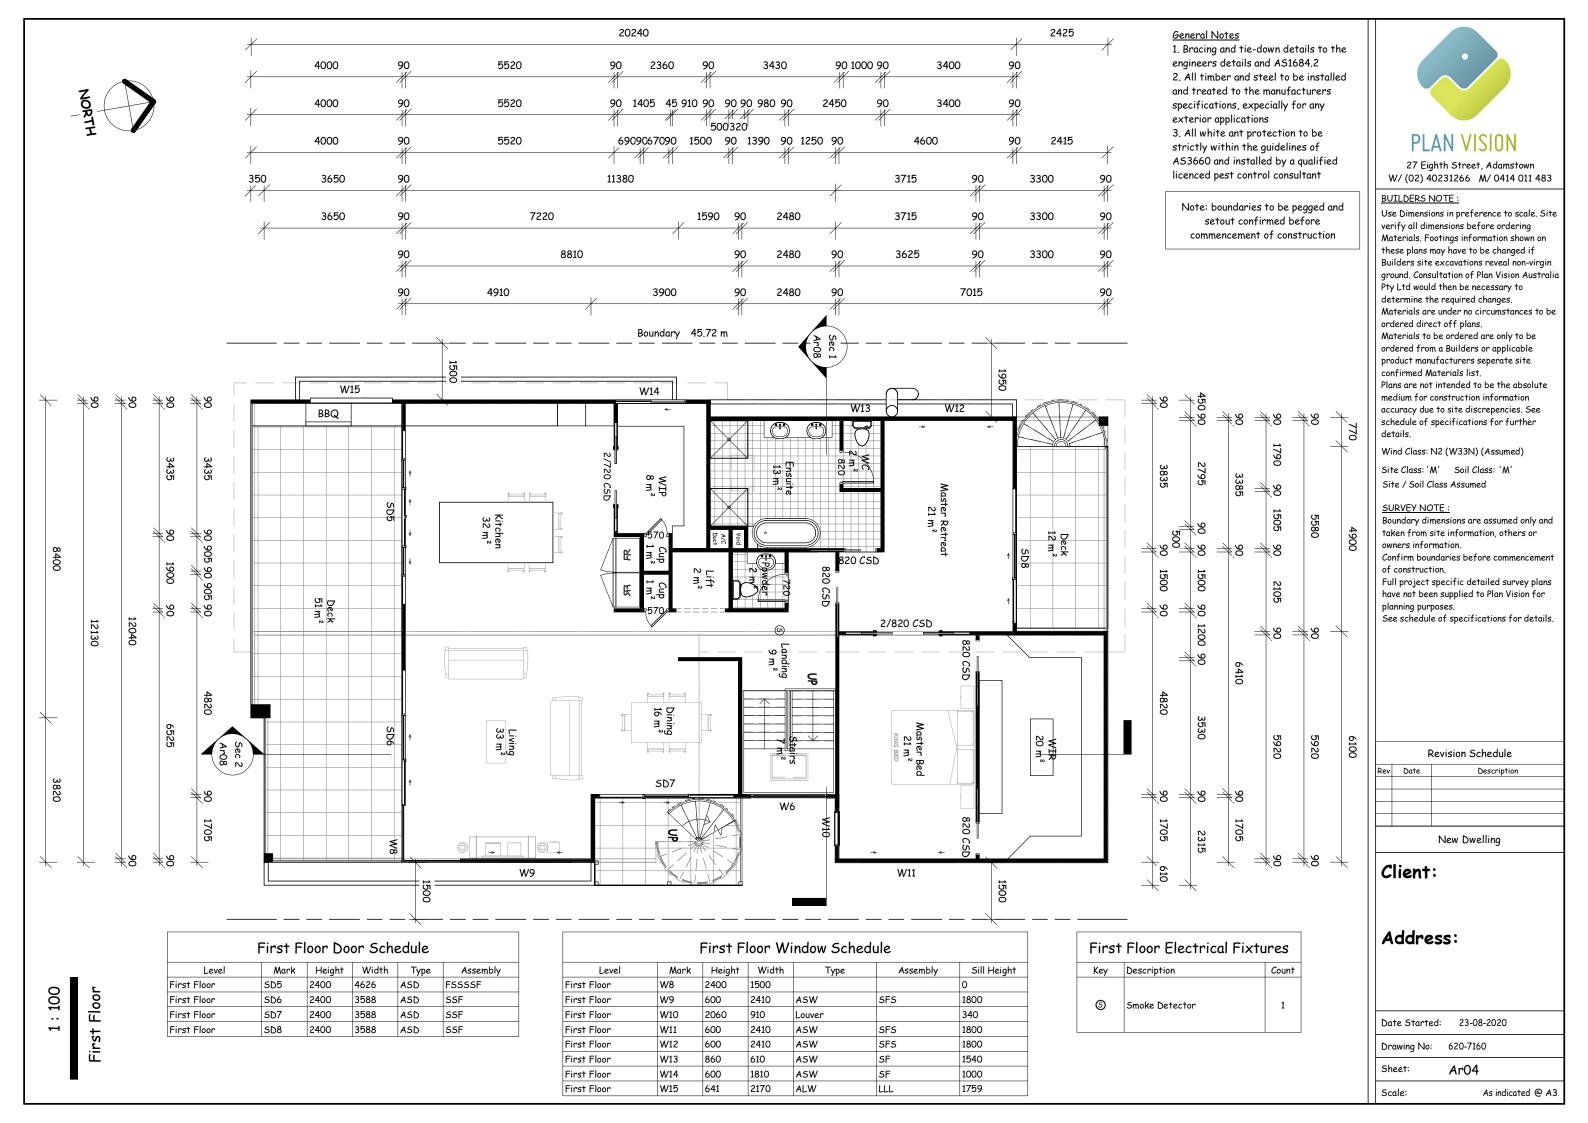

Roof Top Garden Floor

General Notes

- 1. Bracing and tie-down details to the engineers details and AS1684.2
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- 3. All white ant protection to be strictly within the guidelines of AS3660 and installed by a qualified licenced pest control consultant

Note: boundaries to be pegged and setout confirmed before commencement of construction



27 Eighth Street, Adamstown W/ (02) 40231266 M/ 0414 011 483

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Revision Schedule

| Rev | Date | Description |
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New Dwelling

Client:


Address:

Date Started: 23-08-2020

Drawing No: 620-7160


Sheet: Ar05

Scale: 1:100 @ A3

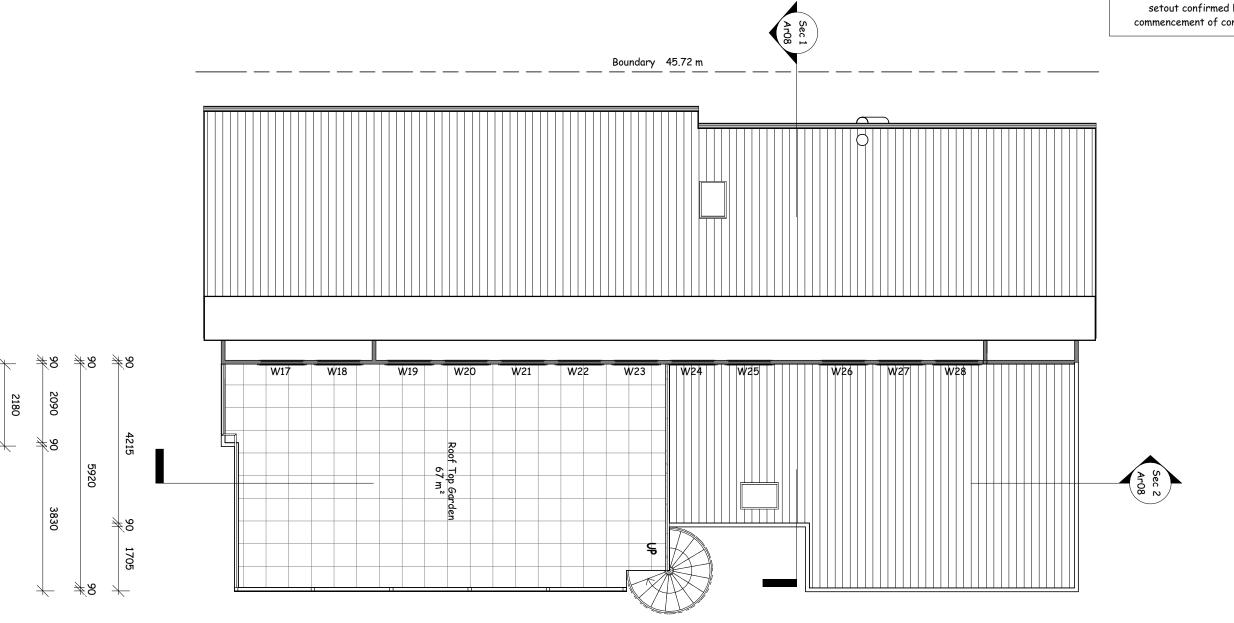

| | | 1050 |
|--------------|-------|---------|
| 90 | 11670 | 90 # |
| 3590 **** | 11320 | 90 # |
| * | 11500 | * |

| Level | Mark | Height | Width | r Window Scl | Assembly | Sill Height |
|-----------------------|------|--------|-------|--------------|----------|-------------|
| Roof Top Garden Floor | W17 | 600 | 1200 | Fixed | Assembly | 560 |
| Roof Top Garden Floor | W18 | 600 | 1200 | Fixed | | 560 |
| Roof Top Garden Floor | W19 | 600 | 1200 | Fixed | | 560 |
| Roof Top Garden Floor | W20 | 600 | 1200 | Fixed | | 560 |
| Roof Top Garden Floor | W21 | 600 | 1200 | Fixed | | 560 |
| Roof Top Garden Floor | W22 | 600 | 1200 | Fixed | | 560 |
| Roof Top Garden Floor | W23 | 600 | 1200 | Fixed | | 560 |
| Roof Top Garden Floor | W24 | 600 | 1200 | Fixed | | 560 |
| Roof Top Garden Floor | W25 | 600 | 1200 | Fixed | | 560 |
| Roof Top Garden Floor | W26 | 600 | 1200 | Fixed | | 560 |
| Roof Top Garden Floor | W27 | 600 | 1200 | Fixed | | 560 |
| Roof Top Garden Floor | W28 | 600 | 1200 | Fixed | | 560 |

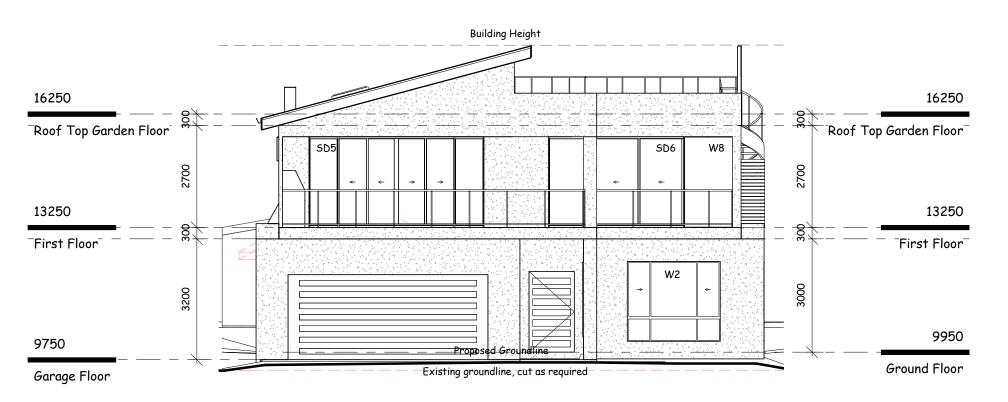

General Notes

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 3. All white ant protection to be
- strictly within the guidelines of AS3660 and installed by a qualified licenced pest control consultant 4. AJ denotes masonary articulation joint, to be installed to AS 3700 section 4.8 requirements

Note: boundaries to be pegged and setout confirmed before commencement of construction

PI AN VISION

27 Eighth Street, Adamstown W/ (02) 40231266 M/ 0414 011 483

Use Dimensions in preference to scale. Site

verify all dimensions before ordering

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schedule of specifications for further

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SURVEY NOTE:

details.

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Confirm boundaries before commencement of construction.

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See schedule of specifications for details.

| | Revision Schedule | | | |
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New Dwelling


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| Date Started: | 23-08-202 | 0 |
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| Drawing No: | 620-7160 | |
| Sheet: | Ar06 | |
| Scale: | | 1:100 @ A3 |


South Elevation

1:100



East Elevation

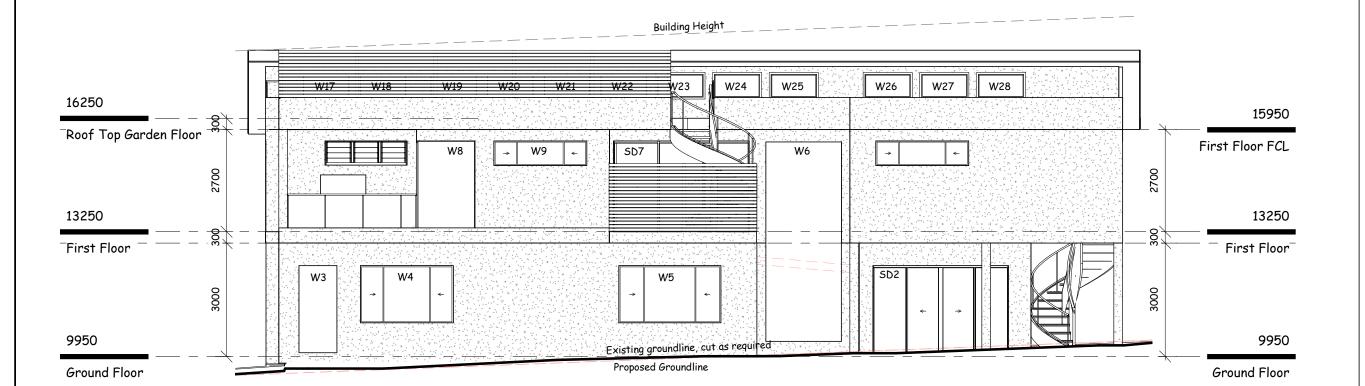1:100

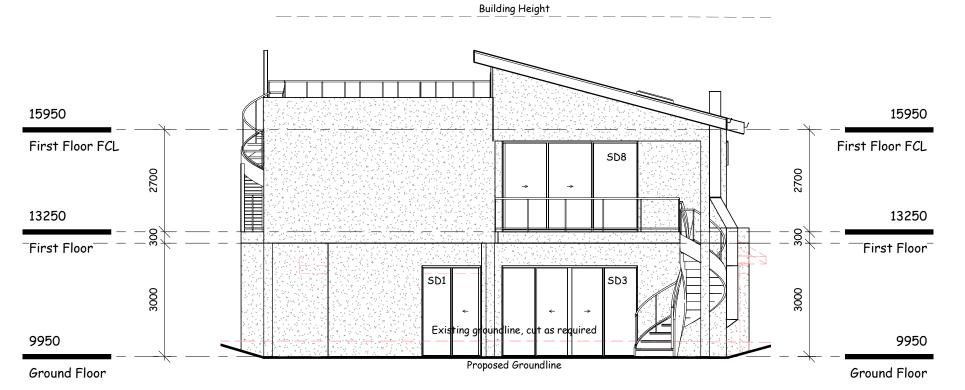

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27 Eighth Street, Adamstown W/ (02) 40231266 M/ 0414 011 483

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schedule of specifications for further details. Wind Class: N2 (W33N) (Assumed)

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| Rev Date | | Description | | |
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| | New Dwelling | | | |


Client:

Address:

| Date Started: | 23-08-2020 |
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| Drawing No: | 620-7160 |
| Sheet: | Ar07 |
| Scale: | As indicated @ A3 |

North Elevation

1:100

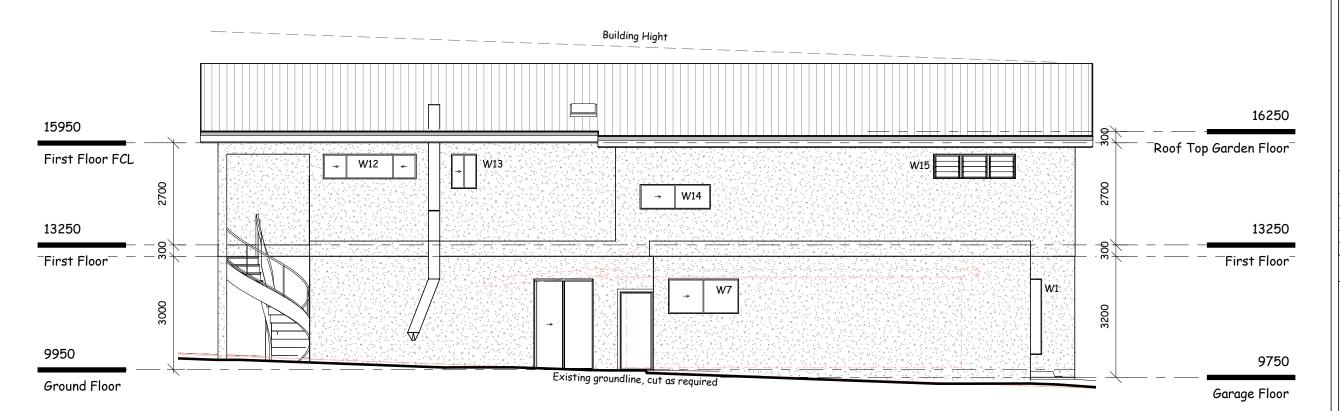

West Elevation


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3D View 1



3D View 2 3D View 3



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New Dwelling

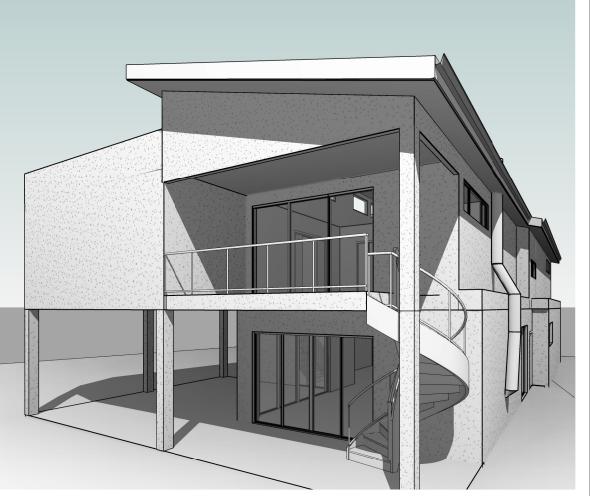Client:

Address:

| | Date Started: | 23-08-2020 | |
|---|---------------|------------|-----|
| - | Drawing No: | 620-7160 | |
| | Sheet: | Ar09 | |
| | Scale: | | @ A |



Boundary 15.24 m Existing Garages 1500 | 45.72 1950 1500 Proposed Dwelling 1500 900 Proposed Driveway Boundary 15.24 m

Note: boundaries to be pegged and setout confirmed before commencement of construction

Erosion and Sediment Controls

General Notes

- This plan shows the control objectives, philosophy and key control works for the site. The contractor shall provide supplementary works that reflect the adopted construction program and practices to ensure that erosion and sediment movement are managed in accordance with the objectives of this
- Erosion and sediment hazard areas include stockpiles, exposed ground, embankments, cuttings concentrated flow paths and waterways.
- This plan is to be used as a guide only. The suitability of erosion and sediment control measures to be evaluated on site and where required, are to be modified under the supervision of a suitably qualified engineer and Council.

Pre-Construction Phase Notes

- Site works are not to start until the erosion and sediment control measures are installed and functional.
- Temporary sediment traps to be installed during construction (where applicable)
- Waste bins are to be provided for building waste or waste enclosure min. $1800 \times 1800 \times 1200$ mm high constructed using star pickets and 1200mm high weed control mat. Arrangement to be made for regular collection and disposal or recycling of construction waste.
- Entry and departure of vehicles is to be confined to the nominated existing vehicle access or stabilised site access. Sediment or barrier fencing will be used to restrict all vehicular movements to that access point. Stabilisation will be achieved by either:
- a) constructing a sealed (eg concrete or asphalt) driveway to the
- b) constructing a stabilised site access according to Council's engineering standards.

Construction Phase Notes


- Topsoil is to be stripped from building site and stockpiled for later use in landscaping the site.
- The footpath and driveway, other than stabilised site access, is not to be disturbed, including stockpiling of materials. Where essential works (eg drainage) are required, the footpath is to be rehabilitated (turfed) as soon as possible.
- Where appropriate, an aggregate bag shall be placed in the gutter below the site access. The bag shall be made from green sediment fence material, or similar. The bag must be at least 450mm long, 200mm diameter, filled with less than 20mm blue metal or crushed rock. If the bag breaks or deteriorates, the bag shall be replaced immediately and the material cleaned out from any gutter, kerb, road surface or stormwater system it has entered. The use of hessian bags, and sand filled bags is not acceptable.
- All sedimentation controls are to be checked daily (at a min. weekly) and after all rain events. All structures to be cleaned on reaching 50% storage capacity to ensure they are maintained and in full functional condition. Excess materials and water from cleaning tools and equipment should not be washed down stormwater drains.

Post-Construction Phase Notes:

- Topsoil is to be re-spread and all disturbed areas rehabilitated (turfed) within 20 working days of completion of works. Where necessary, spray and seed disturbed areas.
- Roof downpipes to be connected to street kerb or other stormwater disposal system as nominated in the plans on completion of roof and guttering as soon as possible.

The proposal dose not exceed 50% of the site coverage

| | Site Area Schedule | | | | | |
|-------------------|----------------------|-----------|---------|--|--|--|
| Name | Area | Coverage | Overall | | | |
| Existing Garage | 67.8 m ² | Covered | 10% | | | |
| Existing Garage | 31.6 m ² | Covered | 5% | | | |
| Proposed Dwelling | 285.8 m ² | Covered | 41% | | | |
| | 385.2 m² | | 55% | | | |
| Remaining Site | 311.6 m ² | Uncovered | 45% | | | |
| | 311 6 m ² | • | 45% | | | |

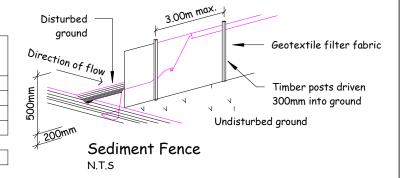



27 Eighth Street, Adamstown

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| | | New Dwelling | | | |

Client:

Address:

Date Started: 23-08-2020 620-7160 Drawing No: Sheet: Ar13 Scale: As indicated @ A3

Site Plan